CITY OF

COLUMBUS, INDIANA TYPICAL CONSTRUCTION GUIDELINES AND DETAILS

ADOPTED BY RESOLUTION NO. 7, 2014 EFFECTIVE FOR ALL WORK ON OR AFTER JANUARY 1, 2015

CITY OFFICIALS


KRISTEN BROWN, Mayor LUANN WELMER, Clerk-Treasurer JEFF LOGSTON, City Attorney BETH FIZEL, P.E. City Engineer

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INDEX

- TITLE AND INDEX
- PAVEMENT AND CURB TYPICAL SECTIONS AND NOTES CONCRETE PAVEMENT, SIDEWALK, DRIVEWAY TYPICAL SECTIONS AND NOTES
- PAVEMENT REPAIR AND RESTORATION TYPICAL SECTIONS AND NOTES SANITARY SEWER TYPICAL DETAILS AND NOTES
- WATERMAIN, METER, AND HYDRANT TYPICAL DETAILS AND NOTES STORM SEWER TYPICAL DETAILS AND NOTES STORM SEWER STRUCTURES, DRAINAGE AND
- EROSION CONTROL TYPICAL DETAILS AND NOTES

 9. EROSION CONTROL TYPICAL DETAILS AND NOTES

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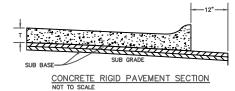
CITY OF COLUMBUS OFFICE OF CITY ENGINEER 123 WASHINGTON STREET COLUMBUS, INDIANA 47201

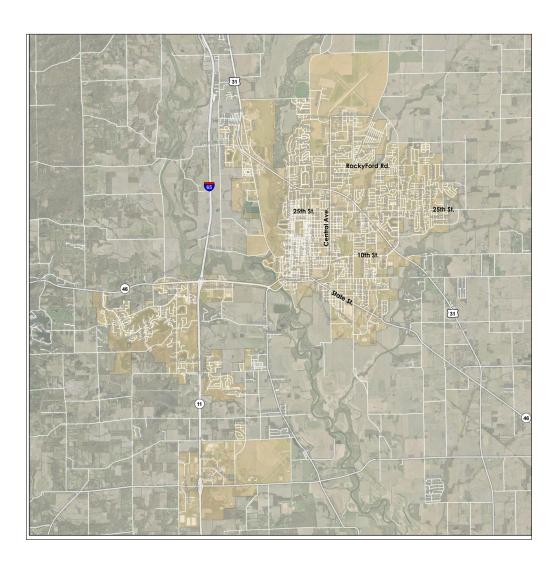
TYPICAL CONSTRUCTION **GUIDELINES AND DETAILS**

CERT.	SHEET:	OF:
	JOB No.	DRG. No.
FILE:		


-LOCATION OF PROFILE GRADE TRANSVERSE SLOPE - 2% TYPICAL (SEE DETAILS)


STANDARD STREET CROSS-SECTION NOT TO SCALE



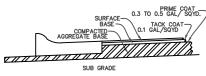


ASPHALT PAVEMENT SECTION BASE TO BE CONSTRUCTED PRIOR TO CONSTRUCTION OF CURB AND GUTTER

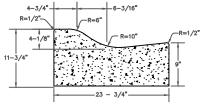

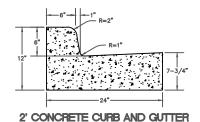


2' ROLL CURB AND GUTTER

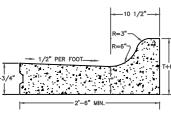

-1/2" PER FOOT INTEGRAL CONCRETE CURB

TYPE I



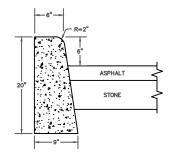


CONCRETE VERTICAL CURB


CURB SECTIONS NOT TO SCALE

PAVEMENT CONSTRUCTION NOTES

- INSTALLATION OF OR PROVISIONS FOR THE INSTALLATION OF ALL UNDERGROUND UTILITIES, INCLUDING SERVICE LATERALS, TO BE PLACED UNDER THE PAYEMENTS SHALL BE ESTABLISHED PRIOR TO THE CONSTRUCTION OF THE PAYEMENTS.
- 2. ALL PAVEMENT, CURBS, SIDEWALKS, RAMPS, ETC. SHALL BE CONSTRUCTED IN ACCORDANCE WITH THE SPECIFICATIONS AND IN CLOSE CONFORMANCE WITH THE LINES, GRADES, THICKNESSES AND TYPICAL CROSS SECTIONS SHOWN ON THE PLANS. MATERIALS AND WORKMANSHIP SHALL BE IN ACCORDANCE WITH DESIGNATED SECTIONS OF THE INDIANA DEPARTMENT OF TRANSPORTATION. "STANDARD SPECIFICATIONS", LATEST EDITION.
- SUBBASE AND SUB GRADE FILL MATERIAL SHALL BE COMPACTED TO A MINIMUM 95% OF THE MAXIMUM DRY DENSITY IN ACCORDANCE WITH ASTM D698.
- 4. ALL PORTLAND CEMENT CONCRETE PAVEMENT STREETS SHALL HAVE JOINT MAINTENANCE CONDUCTED BEFORE THE CITY ACCEPTS OWNERSHIP OF STREET (I.G. CRACK SEAL OR OTHER APPROVED MEASURE) WITHIN THE MAINTENANCE PERIOD.
- 5. WHEREVER RIGID PAVEMENT IS TO BE USED THE CONTRACTOR SHALL SUBMIT A DETAILED PAVING PLAN TO THE CITY ENGINEER. THE PAVING PLAN SHALL SHOW THE LOCATION AND TYPE OF JOINTING TO BE USED IN THE CONSTRUCTION. THE LOCATION AND TYPE OF JOINTING SHALL BE IN ACCORDANCE WITH THE CITY STANDARDS AND GUIDELINES.
- 6. WHENEVER SUB GRADE STABILIZATION IS TO BE USED THE CONTRACTOR SHALL SUBMIT A WRITTEN PLAN DETAILING THE APPLICATION METHOD. THE PLAN MUST COMPLY WITH THE STATE OF INDIANA ENVIRONMENTAL REGULATIONS AND STANDARDS AND BE APPROVED BY THE CITY ENGINEER'S OFFICE.
- RECYCLED CONCRETE MAY BE USED AS # 53 AGG. BASE ON A CASE BY CASE BASIS UPON PRIOR WRITTEN APPROVAL OF THE CITY.
- 8. WHEREVER PROPRIETARY EQUIPMENT IS SPECIFIED, "OR APPROVED EQUAL" IS IMPUED. ALL PROPOSALS FOR SUBSTITUTION SHALL BE SUBMITTED TO THE CITY IN WRITING FOR THEIR APPROVAL.

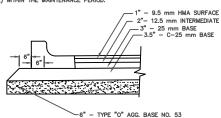


(INTERSECTION OF LOCAL, PLACE OR COLLECTOR WITH ARTERIAL) ARTERIAL APPROACH PAVEMENT SECTION

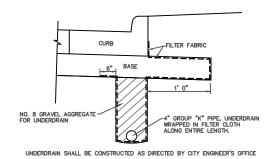

UNDERDRAIN DETAIL

NOT TO SCALE

SHEET TITLE

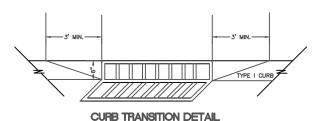

QUALITY CONTROL REQUIREMENTS


- 1. ALL TESTING SHALL BE IN ACCORDANCE WITH THE LATEST INDOT STANDARD SPECIFICATIONS. ALL TESTS WHERE PRACTICABLE SHALL BE WITNESSED BY THE CITY. CONTRACTOR SHALL COORDINATE TESTING SCHEDULE WITH THE CITY LEGINEER'S OFFICE. ALL TEST RESULTS SHALL BE SUBMITTED TO THE CITY ENGINEER'S OFFICE WITHIN 48 HOURS OF THE COMPLETION OF EACH TEST AND PRIOR TO PLACING ANY MATERIAL ON THE SUBBASE/SUBGRADE. THE FREQUENCY OF TESTING WHERE SHOWN IS A MINIMUM. ADDITIONAL TESTING MAY BE REQUIRED AT THE DIRECTION OF THE PUBLIC WORKS INSPECTOR.
- 2. THE DEVELOPER/CONTRACTOR SHALL RETAIN AN INDEPENDENT TESTING FIRM (UNLESS OTHERWISE NOTED) TO PERFORM THE FOLLOWING TESTING: A. SUBGRADE:
 - 1. COMPACTION (FILL SECTIONS): 1_TEST_PER_LIFT_PER_500 LF OF SINGLE LANE WIDTH.
- 2. ADEQUACY OF SUBGRADES SHALL BE DETERMINED SOLELY BY THE PUBLIC WORKS INSPECTOR. A PROOFROIL SHALL BE PERFORMED ON ALL STREET SUB GRADE PRIOR TO PLACING STONE AND INSTALLING CURB. SUBGRADE SHALL MEET INDOOT SPECIFICATION SECTION 207, EXCEPT THAT ONLY THE TOP 6" OF SUBGRADE SHALL BE TESTED FOR 100% STANDARD COMPACTION. PROOFROLLING THAT COMPLES WITH INDOOT SPECIFICATION 203.26 IS ALSO REQUIRED, EXCEPT THAT PROOFROLLING MAY ALSO BE ACCOMPLISHED USING A FULLY LOADED TANDEM OR THE ARLE DUMP TRUCK IN LIEU OF THE SPECIFIED RUBBER THE FOLIER, ROLLER MARKS LESS HANN 1/2" ARE ACCEPTABLE, AS ARE DEFLECTIONS LESS THAN 155 OWER THE LENGTH OF THE ROLLER OR TRUCK. IT THE SPECIFIED RUBBER THE PROOFROLLING OF THE SOLET OR TRUCK IN THE COMPLEX OF THE SECOND OF THE SOLET OR TRUCK IN THE COMPLEX OF THE SECOND OF THE SOLET OR TRUCK IN THE COMPLEX OF THE SECOND OF THE SOLET OR THE SOLET OR THE SOLET OR THE SOLET OF THE SOLET OR THE SOLET OF THE SOLET OR THE SOLET OR THE SOLET OF THE SOLET OR THE S

TANDEM DUMP TRUCK - GROSS WEIGHT 48,000 # TRI-AXLE DUMP TRUCK - GROSS WEIGHT 68,000 #


B. AGGREGATE SUBBASE:

- 1 GRADUATION 1 TEST PER 1000 TONS OR 1 PER WEEK
- 2. COMPACTION 1 TEST PER 500 LF OF SINGLE LANE WIDTH
- C. BITUMINOUS MATERIAL (BASE, INTERMEDIATE AND SURFACE):
- ASPHALT EXTRACTION 1 TEST PER EACH TYPE OF MATERIAL USED PER JOB TEST TO INCLUDE GRADATION, ASPHALT CONTENT, CRUSHED PARTICLE DETERMINATION AND DELETERIOUS DETERMINATION. TEST SHALL BE CERTIFIED PER INDOT CERTIFICATION REQUIREMENTS.
- DETERMINATION. TEST STALL BE CERTIFIED FOR INDIVICE SETTIFICATION REQUIREMENTS.

 2. DENSITY—THE TARGET DENSITY SHALL BE DETERMINED FROM A TEST STRIP CONSTRUCTED PER INDIOT SPECIFICATIONS. THE TARGET DENSITY SHALL NOT BE LESS THAN 96% OF THE UNIT WEIGHT AT THE OPTIMUM BINDER CONTENT NOES AS DETERMINED BY THE MIX DESIGN. THE DENSITY OF EACH SUBLOT WILL BE THE AVERAGE OF FIVE TESTS. A SUBLOT SHALL BE 1000 LF OF SINGLE LANK WIDTH. BREAKDOWN ROLLER SHALL BE MINIMUM 10 TON OR APPROVED VIBRATORY.
- D. CONCRETE FOR CURBING AND DRIVEWAYS:
- 1. AIR AND SLUMP 1 TEST PER DAY FOR POURS OVER 20 CY OR MINIMUM 1 PER WEEK. COMPRESSIVE STRENGTH TESTS — AN ADEQUATE NUMBER OF CONCRETE TEST CYLINDERS SHOULD BE TAKEN TO ENSURE THAT PSI REQUIREMENTS OF THE CONCRETE SECTION ARE MET. A MINIMUM OF ONE SET OF TEST CYLINDERS PER WEEK SHALL PASS THESE REQUIREMENTS.
- 3. CONCRETE STRENGTH SHALL BE A MINIMUM 4000 PSI BEFORE OPEN TO TRAFFIC.
- E. CONGRETE FOR PAYMENT FREQUENCY OF TESTS SHALL BE IN ACCORDANCE WITH THE INDOT FREQUENCY TESTING MANUAL AS SET OUT IN THE SECTION TITLED "CONCRETE PAYMENT AND STRUCTURE MATERIAL".

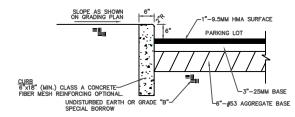

TYPICAL PARKING LOT AND CURB SECTION - ASPHALT

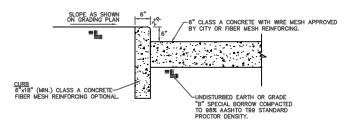

TYPICAL PARKING LOT AND CURB SECTION - CONCRETE


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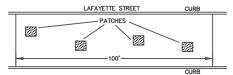
CITY OF COLUMBUS

OFFICE OF CITY ENGINEER 123 WASHINGTON STREET COLUMBUS, INDIANA 47201 PAVEMENT AND CURB

TYPICAL SECTIONS AND NOTES

JOB No. RG. No.



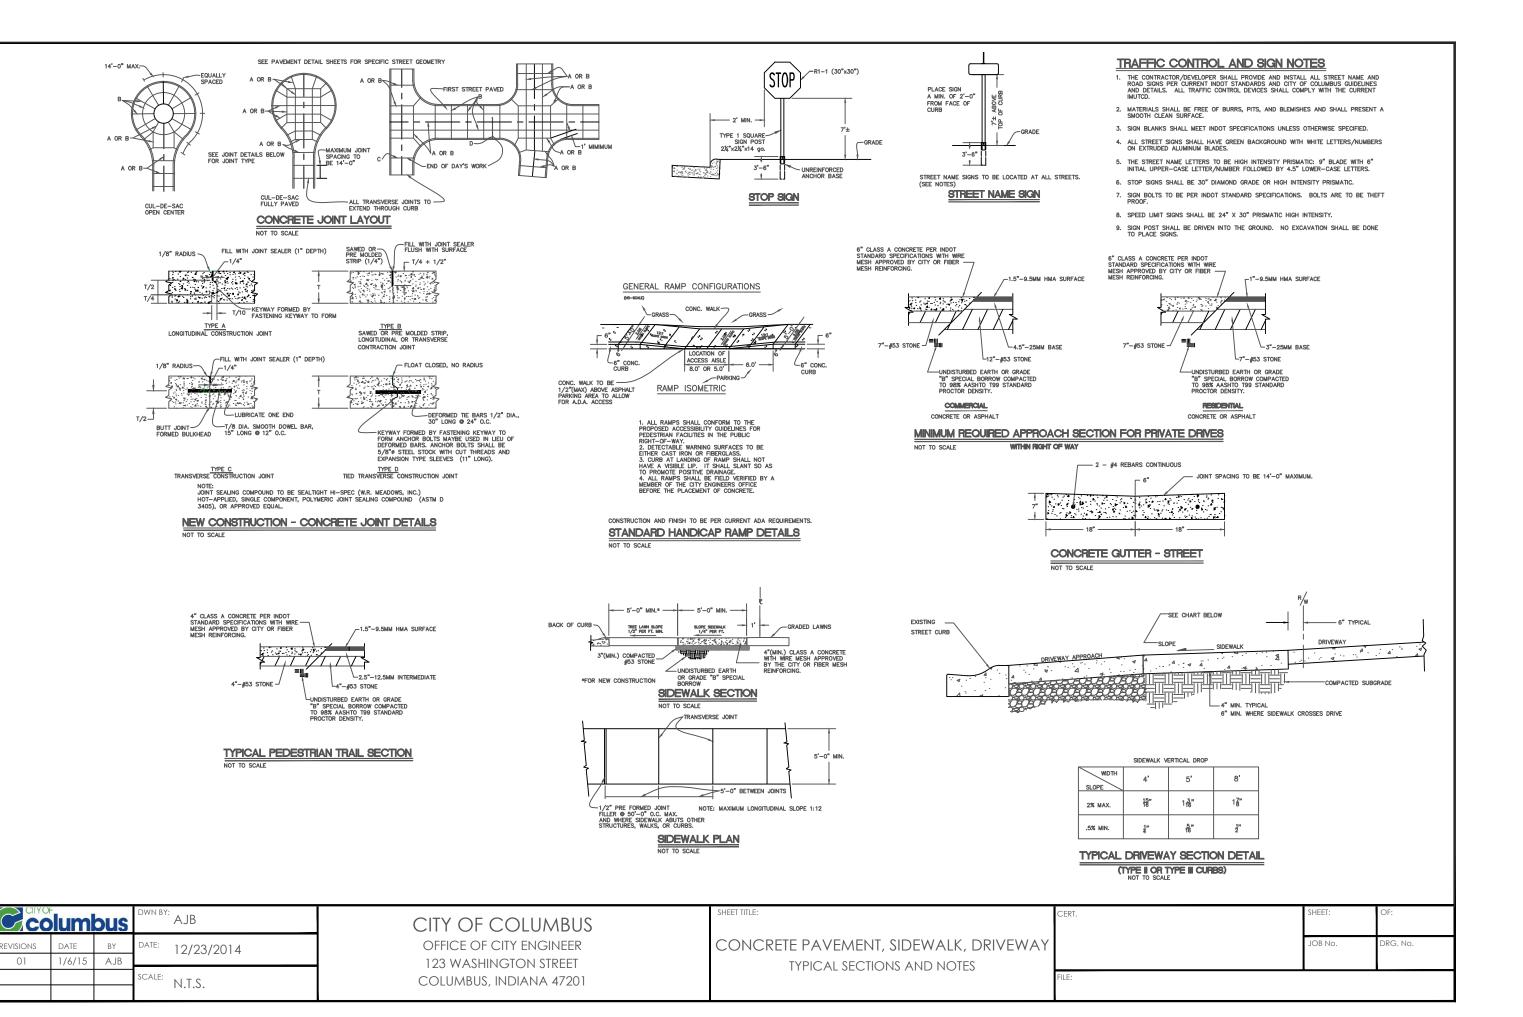

MULTIPLE CUTS SHALL BE DEFINED AS CITY STREET OR ALLEY, ASPHALT OR CONCRETE, THAT HAVE THE FOLLOWING CONDITIONS:

1. FOUR (4) OR MORE PATCHES PER 100 LINEAR FEET OF ROADWAY WITHIN A ONE (1) YEAR PERIOD OF TIME, AND


2. AREA CUT IS GREATER THAN 64 S.F. IN 100 LINEAR FEET OF ROADWAY WITHIN A ONE (1) YEAR PERIOD OF TIME. MULTIPLE CUTS TO BE RESTORED AS FOLLOWS:




1. NEW PAVEMENT AREAS SHALL NOT HAVE GAPS OF LESS THAN 100 FEET. MINIMUM LENGTH OF NEW PAVEMENT SHALL BE 50 FEET.


2. THE CITY ENGINEER SHALL HAVE THE AUTHORITY TO NEGOTIATE A PAYMENT FROM THE UTILITY COMPANY IN LIEU OF RESURFACING. THE PAYMENT SHALL BE BASED UPON THE UNIT PRICE FOR ASPHALT FROM THE CITY'S MOST RECENT RESURFACE CONTRACT AND THE AREA THAT WOULD HAVE TO BE RESURFACED ACCORDING TO THIS STANDARD. THE PAYMENT SHALL BE PRORATED ACCORDING TO THE CITY'S RESURFACION SCHEDULE AT A RATE OF 10% PER YEAR. FOR EXAMPLE, IF THE STREET IS SCHEDULED TO BE RESURFACED IN ONE YEAR, ONLY 10% MILL BE CHARGED, IN 2 YEARS ONLY 20%, ETC. THIS PAYMENT OPTION SHALL NOT APPLY TO RECENTLY RESURFACED STREETS.

CITY OF COLUMBUS METHOD FOR REPLACING MULTIPLE CUTS

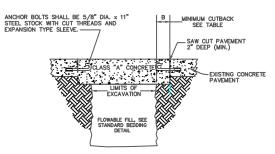


CONCRETE PAVEMENT REPAIR

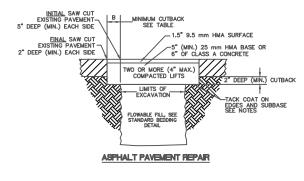

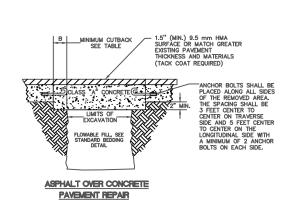

MATCH EXISTING GRADE

PROPOSED ASPHALT PAVEMENT EXISTING ASPHALT PAVEMENT -1.5"- 9.5mm HMA SURFACE 4.5"- 25mm HMA BASE #53 COMPACTED AGGREGATE BASE EXISTING SUB GRADE SAW CUT EDGE OF EXISTING ASPHALT PAVEMENT TO FULL DEPTH LAP JOINT DETAIL

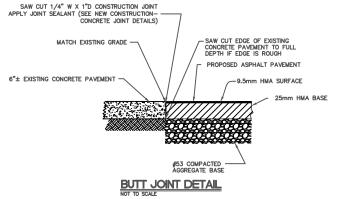

MILL SURFACE 1.5" DEEP FOR 18" FROM SAW-CUT EDGE, TACK COAT ALL EXPOSED SURFACES, AND OVERLAY, WITH 1.5" OF ASPHALTIC SURFACE, CONTINUOUS WITH

FINAL	CUTBACK TABLE
В	TRENCH WIDTH
6"	3'-0" OR LESS
9"	3'-1" TO 5'-0"
12"	5'-1" OR GREATER

PERMANENT PAVEMENT RESTORATION NOT TO SCALF

Columbus BY 12/23/2014 SCALE: N.T.S.

CITY OF COLUMBUS OFFICE OF CITY ENGINEER 123 WASHINGTON STREET COLUMBUS, INDIANA 47201

PAVEMENT REPAIR AND RESTORATION TYPICAL SECTIONS AND NOTES

JOB No. RG. No.

PAVEMENT RESTORATION NOTES

. MAINTENANCE OF ANY STREET RESTORATION OR REPAIR SHALL BE THE RESPONSIBILITY OF THE INDIVIDUAL UTILITY OR DEVELOPER AUTHORIZED TO MAKE SUCH REPAIR UNTIL THE STREET HAS BEEN RESURFACED.

PERMANENT PAVEMENT RESTORATION:

- THIS STREET REPAIR PROCEDURE SHALL BE USED FROM APRIL 15th UNTIL NOVEMBER 15th OR AS LONG AS H.M.A. IS AVAILABLE.
 BED PIPE OR CONDUIT WITH APPROVED COMPACTED GRANULAR MATERIAL . (SAND, PIT RUN,

- OR AS LONG AS H.M.A. IS AVAILABLE.

 BED PIPE OR CONDUIT WITH APPROVED COMPACTED GRANULAR MATERIAL. (SAND, PIT RUN, PR B-BARROW)

 FLOWABLE FILL SHALL HAVE A COMPRESSIVE STRENGTH OF 50 TO 150 P.S.I. FLOWABLE FILL SHALL BE SUPPLIED BY A PROVIDER APPROVED BY THE CITY ENGINEER. APPROVAL SHALL BE BASED ON INDOT TREQUALIFICATION AND SUBMITTAL OF AN ACCEPTABLE MIX DESIGN(S).

 4. ASPHALT STREETS: ASPHALT PATCH SHALL BE 50 BASE OR EQUAL, 6" MINIMUM DEPTH OR MATCH EXISTING, CONCRETE PATCH SHALL BE 6" MINIMUM DEPTH OR MATCH EXISTING, HIGH STIRENGTH INDOT CLASS "C", WITH 2% CALCIUM AND SHALL BE PLACED WITHIN 24 HOURS.

 5. CONCRETE STREETS: CONCRETE PATCH SHALL BE 6" MINIMUM DEPTH OR MATCH EXISTING, HIGH STRENGTH INDOT CLASS "C", WITH 2% CALCIUM, FLUSH WITH EXISTING SURFACE, BROOM FINISHED AT RIGHT ANGLES TO TRAFFIC FLOW AND SHALL BE PLACED WITHIN 24 HOURS.

 6. PLACE 1.5" PATCH OF #11 SURFACE H.M.A. (WITHIN 24 HOURS) FLUSH WITH EXISTING SURFACE. SURFACE OF CONCRETE OR ASPHALT PATCH AND EDGES OF EXISTING ASPHALT SHALL BE TACK COATED BEFORE PLACING H.M.A. PATCH.

 7. IF MORE THAN ONE CULT IS MADE ON A CITY STREET, AND THE DISTANCE BETWEEN THE TWO IS 5"-O" OR LESS, THE CONTRACTOR OR PERSONS MAKING THE REPAIR WILL BE REQUIRED TO REMOVE THE SURFACE BETWEEN THE CUTS AND MAKE ORE REPAIR.

 8. CONTRACTOR SHALL NOTIFY THE CITY ENGINEER'S OFFICE AT (812) 376—2540 BEFORE PLACING THE PATCH.

 9. ALL OVERCUTTING AND ENTIRE PERIMETER OF FINAL REPAIR TO BE CLEANED AND SEALED WITH A SPHALT CRACK SEALER.

 10. FLOWABLE FILL IS NOT TO BE USED AS A TEMPORARY DRIVING SURFACE EXCEPT FOR AN EMERGENCY AND THEN FOR A PERIOD NOT TO EXCEED 24 HOURS.

TEMPORARY PAVEMENT REPAIR:

- THIS STREET REPAIR PROCEDURE SHALL BE USED FROM NOVEMBER 16th UNTIL APRIL 14th OR AS LONG AS H.M.A. IS NOT AVAILABLE.
 BED PIPE OR CONDUIT WITH APPROVED <u>COMPACTED</u> GRANULAR MATERIAL. (SAND, PIT RUN OR
- B-BORROW).

 3. FLOWABLE FILL SHALL HAVE A COMPRESSIVE STRENGTH OF 50 TO 150 P.S.I FLOWABLE FILL SHALL BE SUPPLIED BY A PROVIDER APPROVED BY THE CITY ENGINEER. APPROVAL SHALL BE BASED ON INDOT PREQUALIFICATION AND SUBMITTAL OF ACCEPTABLE MIX DESIGN(S)

 4. FLOWABLE FILL IS NOT TO BE USED AS A TEMPORARY DRIVING SURFACE EXCEPT FOR AN EMERFENCY REPAIR AND THEN FOR A PERIOD NOT TO EXCEED 24 HOURS.

 5. ASPHALT STREETS: CONCRETE PATCH SHALL BE 6" MIN. DEPTH OR MATCH EXISTING, PLACED WITHIN 24 HOURS.

- 24 HOURS.

 ONORRIE STREETS: CONCRETE PATCH SHALL BE 6" MINIMUM DEPTH OR MATCH EXISTING, FLUSH WITH EXISTING SURFACE AND BROOM FINISHED AT RIGHT ANGLES TO TRAFFIC FLOW, <u>PLACED WITHIN 24</u>

- EXISTING SURFACE AND BROOM FINISHED AT RIGHT ANGLES TO TRAFFIC FLOW, PLACED WITHIN 24 HOURS

 7. ALL CONCRETE SHALL BE INDOT CLASS "C", WITH 2% CALCIUM AND SHALL BE COVERED AND INSULATED FOR 4 HOURS PRIOR TO BEING OPENED TO TRAFFIC.

 8. PLACE TEMPORARY 2" PATCH OF COLD MIX FLUSH WITH EXISTING SURFACE WITHIN 24 HOURS. TEMPORARY PATCH SHALL BE REMOVED AND REPLACED WITH 2" OF 11 H.M.A. SURFACE AS SOON AS H.M.A. BECOMES AVAILABLE. SURFACE OF CONCRETE AND EDGES OF EXISTING ASPHALL SHALL BE TACK COATED BEFORE PLACING H.M.A.


 9. IF MORE THAN ONE CUT IS MADE ON A CITY STREET, AND THE DISTANCE BETWEEN THE TWO IS 5"-O" OR LESS, THE CONTRACTOR OR PERSONS MAKING THE REPAIR WILL BE REQUIRED TO REMOVE THE SURFACE BETWEEN THE CUTS AND MAKE ONE REPAIR.

 10. CONTRACTORS SHALL NOTIFY THE CITY ENGINEER'S OFFICE AT (812) 378—254Q BEFORE PLACING CONCRETE OR ASPHALT SHALT PATCH.

 11. ALL OVERCUTTING AND ENTIRE PERIMETER OF FINAL REPAIR TO BE CLEANED AND SEALED WITH ASPHALT CRACK SEALER.


SPECIAL SURFACE STREETS:


. ANY SPECIAL SURFACES SHALL BE RESTORED IN-KIND. FOR EXAMPLE. BRICK SURFACE STREETS REQUIRE ALL PAVEMENT CUTS TO BE RESTORED WITH BRICK. COBBLESTONE SURFACE STREETS MUST BE RESTORED WITH COBBLESTONE. PERMIT HOLDER SHALL SALVAGE AS MUCH OF THE EXISTING BRICK OR COBBLESTONE POSSIBLE FOR REUSE IN THE RESTORATION AND SHALL SUPPLY ANY REMAINING MATERIAL REQUIRED FOR THE RESTORATION.

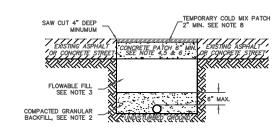



TEMPORARY PAVEMENT REPAIR


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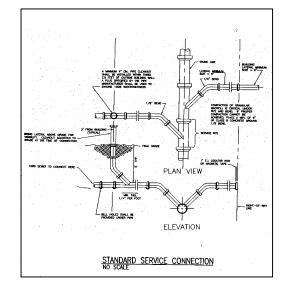


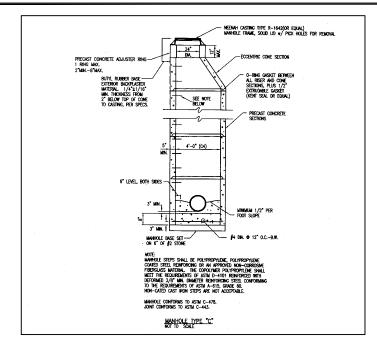


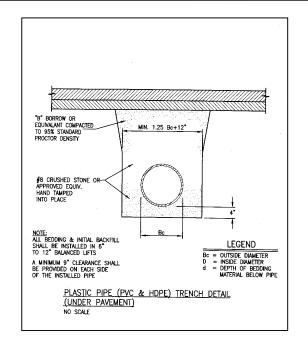


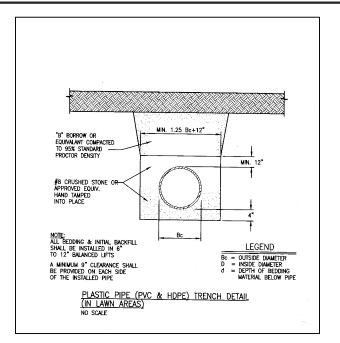

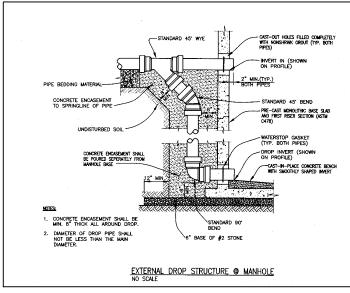

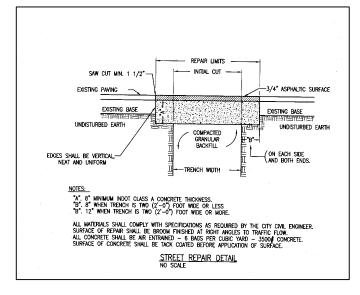

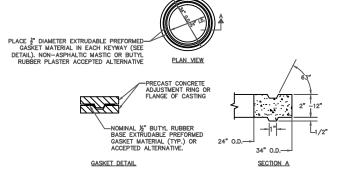

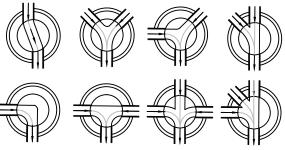

STANDARD MANHOLE BENCHWALLS

SHEET TITLE:

PRECAST CONCRETE ADJUSTING RING DETAIL NOT TO SCALE

columbus AJB DATE 12/23/2014 SCALE: N.T.S.

CITY OF COLUMBUS OFFICE OF CITY ENGINEER 123 WASHINGTON STREET COLUMBUS, INDIANA 47201

SANITARY SEWER TYPICAL DETAILS AND NOTES

SANITARY SEWER NOTES:

- ALL SANITARY SEWER PIPE IS TO BE SDR 35 PVC PRESSURE SEWER PIPE WITH COMPRESSION FITTINGS PER ASTM D-3034, AND SHALL BE PRESSURE TESTED TO ASSURE WATER TIGHTNESS PRIOR TO BACKFILLING.
- 2. SEWERS SHALL BE LAID AT LEAST (10) FEET, HORIZONTALLY , FROM ANY WATER MAIN

CROSSINGS OF BURIED SEWERS AND WATER LINES SHALL BE AVOIDED AS MUCH AS POSSIBLE, HOWEVER WHERE CROSSINGS ARE RICESSARY, A MINIMUM OF TIS INCHES VERTICAL CLEARANCE SHALL BE MAINTAINED (MEASURED FROM THE BOTTOM OF THE UPPER PIPE TO THE TOP OF THE LOWER PIPE), PREFERABLY WITH THE WATER MAIN ABOVE THE SEWER.

WHEN IT IS IMPOSSIBLE TO MAINTAIN PROPER HORIZONTAL AND VERTICAL SEPERATION, THE SEWER SHALL BE CONSTRUCTED OF WATERWORKS GRADE DUCTILE IRON PIPE WITH MECHANICAL JOINTS OR SDR 26 PVC PRESSURE SEWER PIPE IN ACCORDANCE WITH ASTM D-3034 WITH COMPRESSION FITTINGS, AND SHALL BE PRESSURE TESTED TO ASSURE WATER TIGHTINESS PRIOR TO BACKFILLING.

- 3. ALL STUBS AND INDIVIDUAL SERVICE LINES SHALL BE 6" PIPE AS NOTED
- 4. CONTRACTOR IS TO PROVIDE A MEANS OF ACCESS TO ALL RESIDENCES AND BUSINESSES DURING CONSTRUCTION.
- CONTRACTOR IS TO PROVIDE ADEQUATE EROSION CONTROL DURING CONSTRUCTION. ANY DISTURBED AREAS ARE TO BE RESEEDED WITH IN 7 DAYS OF FINISHED GRADING.
- IT SHALL BE THE CONTRACTORS RESPONSIBILITY FOR COMPLIANCE WITH THE REQUIREMENTS OF SECTION 15, 1990 OSHA EXCAVATION STANDARDS, 29 CFR 1926 SUBPART P.
- 7. USE HEAVY DUTY NEENAH #R-1642, MANHOLE FRAME w/ PICK HOLES FOR REMOVAL (OR EQUAL)
- 8. WHERE MANHOLES OCCUR IN FLOOD PLAN OR DITCH, USE WATERTIGHT CASTING AND LIDS. LOCATION AS SHOWN ON PLANS.
- WATERTIGHT MANHOLE CASTINGS SHALL BE FURNISHED WITH A ROUND RUBBER GASKET, CONCEALED WATERTIGHT PICK HOLES, AND BRONZE CAPSCREW.
- 10. FOR MANHOLE IN PRESENT STREETS, COVERS SHALL MATCH EXISTING GRADE.
- 11. ALL SLOPES TO BE FINISHED WITHIN 1" TO TOP OF CASTING.
- 12. ALL JOINTS TO BE WATERTIGHT "O" RING TYPE PER A.S.T.M. SPECIFICATION C-443, LATEST EDITION.
- 13. ALL PRECAST CONES AND BARRELS TO BE REINFORCED PER A.S.T.M. SPECIFICATION C-487, LATEST EDITION.
- 14. MANHOLE STEPS TO BE STANDARD PLASTIC WITH STEEL REINFORCING.
- 15. DROP MANHOLES SHALL BE PROVIDED FOR ANY SEWER ENTERING A MANHOLE AT AN ELEVATION OF 24" OR MORE ABOVE MANHOLE INVERT; DROP PIPES TO BE OF THE SAME MATERIAL AS THE SEWER MAIN.
- 16. ALL WYES AND HOUSE SERVICE RUNS SHALL BE PLUGGED WITH PLUGS HAVING RESILIENT JOINT MATERIAL MATCHING THAT OF THE PIPE JOINTS.
- ROOF DRAINS, FOUNDATION DRAINS, OR ANY OTHER CLEAN WATER CONNECTIONS TO THE SANITARY SEWER ARE PROHIBITED.
- 18. INSPECTION: PERIODIC OBSERVATION OF WORK IN PROGRESS MAY BE PROVIDED BY COLUMBUS UTILITIES OR THEIR DESIGNEE. THE SANITARY SEWER UTILITY SHALL BE NOTIFIED BY THE CONTRACTOR PRIOR TO HIS STARTING WORK AND PRIOR TO RESTARTING WORK AFTER DELAYS OR SHUT-DOWNS
- ALL CONSTRUCTION SHALL BE IN ACCORDANCE WITH THE HEREON PLANS AND IN ACCORDANCE WITH ANY APPLICABLE FEDERAL, STATE, LOCAL CODES OR LAWS, AND COLUMBUS UTILITIES HANDBOOKS.

CERTAIN ITEMS IN THESE PLANS ARE IDENTIFIED BY SPECIFIC MODEL OR ITEM NUMBERS AS SUPPLIED BY NAMED MANUFACTURERS. THE ITEMS ARE SO SPECIFIED BECAUSE THEY EXHIBIT A PERFORMANCE STANDARD REQUIRED BY THE SPECIFIC SITE CONDITIONS. THESE ITEMS MAY ONLY BE SUBSTITUTED IF THE CONTRACTOR MAKES WRITTEN REQUEST OF THE DESIGNER, STATING THE MANUFACTURER AND MODEL OR ITEM NUMBER OF THE REQUESTE REPLACEMENT OF THE SPECIFIED THEM. SUBSTITUTION MAY OCCUR AFTER THE CONTRACTOR RECEIVES WRITTEN APPROVAL FROM BOTH THE DESIGNER AND ALL APPROVING AGENCIES.

DEFLECTION AND LEAKAGE TESTING

A DEFLECTION AND LEAKAGE TEST SHALL ON ALL SEWER PIPE INSTALLED DURING THE CONSTRUCTION OF THIS PROJECT IN ACCORDANCE WITH 327 IAC 3-6-19. A DEFLECTION TEST SHALL BE PERFORMED ON ALL FLEXBLE PIPE FOLLOWING THE ELAPSE OF 30 DAYS AFTER THE PLACEMENT OF FINAL BACKFILL. NO PIPE SHALL EXCEED A DEFLECTION TEST SHALL BE NO LESS THAN DAMETER OF RIGID BALL OR MANDREL USED FOR A DEFLECTION TEST SHALL BE NO LESS THAN SHALL EXCEED A DEFLECTION TEST SHALL BE NO LESS THAN SPECIFIED IN THE CORRESPONDING ASTM STANDARD. THE TEST DEPENDENT ON MINTAL SPECIFIED IN THE CORRESPONDING ASTM STANDARD. THE TEST ANALL NOT BE PERFORMED WITH THE ALD OF A MECHANICAL PULLURIS DEPENDAND. THE TEST SHALL HOT BE PERFORMED WITH THE ALD OF A MECHANICAL PULLURIS DEPENDAND. THE AID OF A MECHANICAL PULLING DEVICE. ALL GRAVITY SEWER SHALL BE TESTED USING THE FOLLOWING LEAKAGE TESTS:

A HYDROSTATIC TEST SHALL BE PERFORMED WITH A MINIMUM OF 2 FEET OF POSITIVE HEAD. THE RATE OF EXFILTRATION OR INFILTRATION SHALL NOT EXCEED TWO HUNDRED GALLONS PER INCH OF PIPE DIAMETER PER LINEAR MILE PER DAY.

AIR TEST SHALL CONFORM TO ASTM F 1417-92


VACUUM TESTING


DEPTH (FEET)


ALL SANITARY MANHOLES SHALL BE TESTED IN ACCORDANCE WITH ASTM C 1244—93 ALL PIPES ENTERING THE MANHOLE SHALL BE PLUGGED. THE TEST HEAD SHALL BE PLACED AND THE SEAL INFLATED PER MANUFACTURER'S RECOMMENDATIONS. A VACUUM PUMP OF TEN INCHES OF MERCURY SHALL BE DRAWN AND THE VACUUM PUMP SHUT OFF. WITH THE VALVES CLOSED, THE TIME SHALL BE MEASURED FOR THE VACUUM TO DROP NINE INCHES. FOLLOWING ARE MINIMUM ALLOWABLE TEST TIMES FOR MANHOLE ACCEPTANCE AT THE SPECIFIED VACUUM DROP. (NUMBERS ARE PER ASTM C 1244—93 FOR 48" DIA. MANHOLE)


TIME (SECONDS)


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	JOB No.	DRG. No.

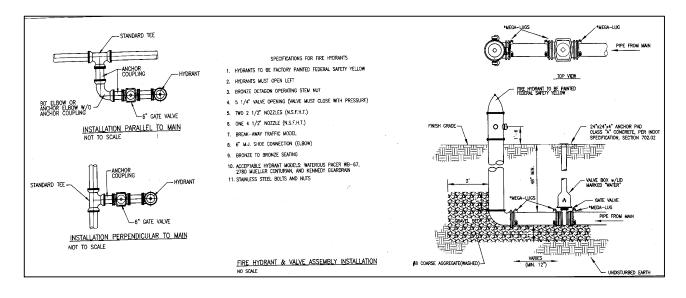


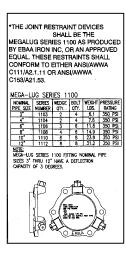


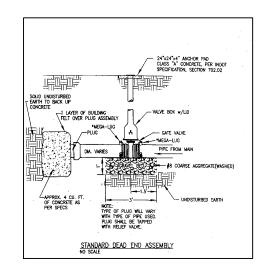


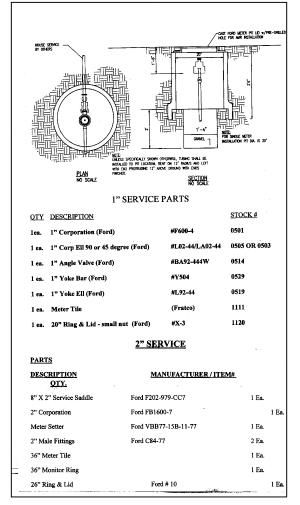


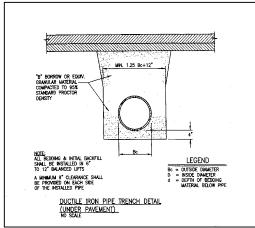

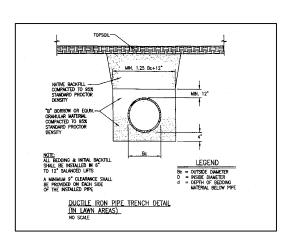

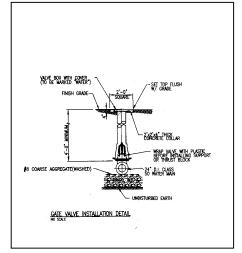

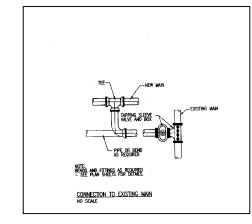

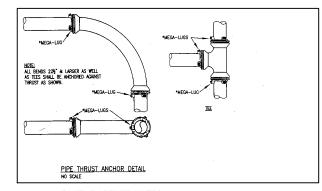

SANITARY SEWER NOTES:

UNLESS SPECIFICALLY SUBSTITUTED IN SPECIAL PROVISIONS

- 1. TOP OF WATER MAIN TO BE PLACED AT MINIMUM OF 48" BELOW FINISHED GRADE.
- 2. FIRE HYDRANTS TO BE LOCATED 2.0' FROM BACK OF WALK & ON LOT LINES UNLESS OTHERWISE NOTED ON PLANS.
- ALL WATER LINE TO BE PLACED IN AN AREA BETWEEN BACK OF CURB AND FACE OF WALK. ALL VALVES AND TEES TO BE LOCATED WITHIN 5' OF LOT LINES AND ARE NEVER TO BE PLACED UNDER PAVEMENT.
- ALL WATER LINE TO BE ANSI/AWWA C151/A21.51 BITUMINOUS COATED DUCTILE IRON PIPE. THE PIPE INTERIOR SHALL BE CEMENT MORTAR LINED AND SEAL COATED IN COMPLIANCE WITH THE LATEST REVISION OF ANSI/AWWA C104/A21.4
- WHERE WATER AND SEWER LINES CROSS AND AN 18" MINIMUM VERTICAL SEPARATION CANNOT BE MAINTAINED. THE SEWER LINE MUST BE CONSTRUCTED OF WATERWORKS GRADE DUCTILE IRON PIPE WITH MECHANICAL JOINTS OR ASTIM D3034 SDR21 PVC SEWER PIPE WITH GASKETED, COMPRESSION TYPE JOINTS WITHIN 10' OF THE WATER LINE.
- 6. IF PARALLEL WATER AND SEWER LINES DO NOT MAINTAIN A 10' MINIMUM SEPARATION, THEN
 THE SEWER LINE MUST NE CONSTRUCTED OF WATERWORKS GRADE DUCTILE IRON PIPE WITH
 MECHANICAL JOINTS OR ASTM D3034 SDR21 PVC SEWER PIPE WITH GASKETED, COMPRESSION
 TYPE JOINTS.
- PERIODIC OBSERVATION OF WORK IN PROGRESS MAY BE PROVIDED BY COLUMBUS CITY UTILITIES. THE COLUMBUS CITY UTILITIES SHALL BE NOTIFIED BY THE CONTRACTOR PRIOR TO HIS STARTING WORK AND PRIOR TO RESTARTING WORK AFTER DELAYS OR SHUT-DOWNS.
- 8. ALL WATER MAIN CONSTRUCTION SHALL BE IN COMPLIANCE WITH THE COLUMBUS CITY UTILITIES WATER HANDBOOK.
- IT IS THE CONTRACTORS RESPONSIBILITY TO LOCATE ALL UTILITIES IN THE CONSTRUCTION AREA AND VERIFY THE LOCATION OF EXISTING WATER MAINS.
- 10. ALL NUTS AND BOLTS ARE TO BE STAINLESS STEEL.

SANITARY SEWER NOTE


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columbus			DWN BY:	AJB
REVISIONS	DATE	BY	DATE:	12/23/2014
			SCALE:	N.T.S.

CITY OF COLUMBUS
OFFICE OF CITY ENGINEER
123 WASHINGTON STREET
COLUMBUS, INDIANA 47201


WATERMAIN, METER, AND HYDRANT TYPICAL DETAILS AND NOTES

CERT.	SHEET:	OF:
	JOB No.	DRG. No.
FILE:		

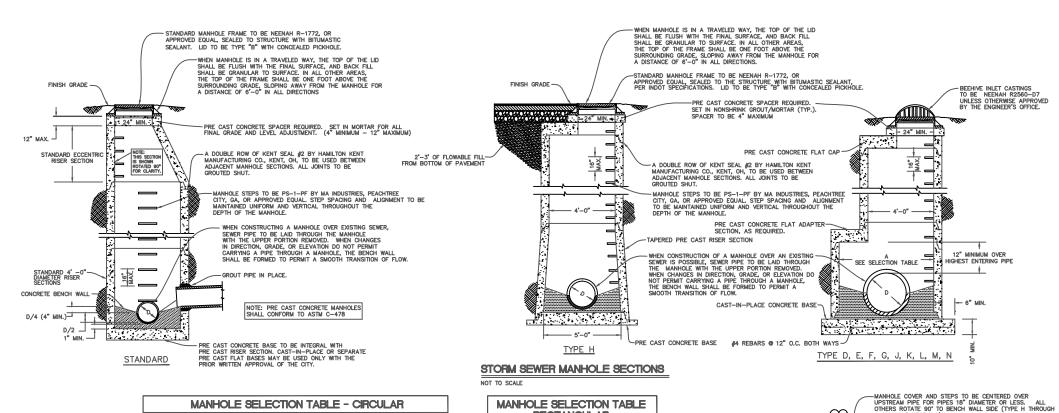

MANHOLE SELECTION TABLE - CIRCULAR						
TYPE	PIPE DIAMETER D	RISER DIAMETER	MAXIMUM PIPE SIZE FOR MAIN LINE	MAXIMUM PIPE SIZE 90° TO MAIN LINE		
STANDARD	UP TO 24"	48"	24"	24"		
Н	24"-36"		36"	30"		
J	24"-36"	60"	36"	30"		
K	36"-48"	72"	48"	36"		
L	48"-54"	96"	54"	48"		
M 54"-72"		102"	72"	66"		
N	72"-84"	108"	84"	72"		



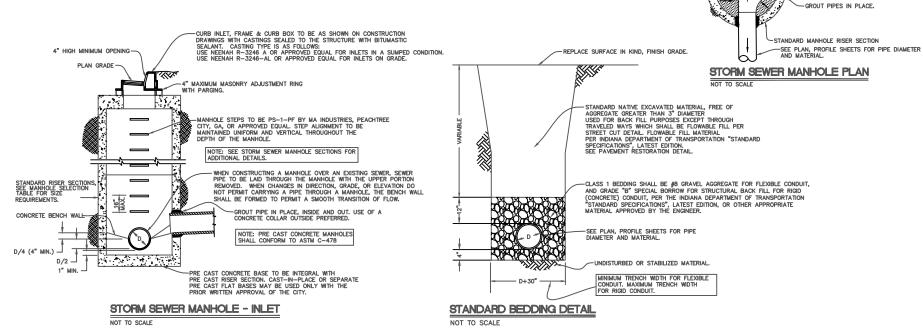

STORM SEWER NOTES

- STORM SEWER PIPE AND APPURTENANCES SHALL CONFORM TO CITY OF COLUMBUS STORMWATER DESIGN MANUAL, AND CITY OF COLUMBUS ORDINANCE NO. 29-2008, "STORMWATER MANAGEMENT IN THE CITY OF COLUMBUS, INDIANA", FOR DESIGN AND MATERIALS.
- CONSTRUCTION PROCEDURES AND MATERIALS SHALL COMPLY WITH APPLICABLE SECTIONS OF THE INDIANA DEPARTMENT OF TRANSPORTATION STANDARD SPECIFICATIONS, LATEST EDITION
- PIPE AND FITTINGS USED IN STORM SEWER CONSTRUCTION SHALL BE CONCRETE PIPE (ASTM C-76), PVC PIPE (4"-24" ONLY; ASTM 3034-SDR 35, ASTM F-679, OR ASTM F-794). HOBAS PIPE (24" AND LARGER ONLY; ASTM D3262, D4161, D2412, FIBERGLASS SLEEVE COUPLINGS USING ELASTOMERIC SEALING GASKETS MADE OF EPDM COMPOUND PER ASTM D 4161), ADS N-12 (36") AND ADS N-12HC (42"-48" ONLY) DUAL WALL SINGLE MOLD HDPE PIPE WITH WATER TIGHT INTEGRAL BELL COUPLERS (AASHTO M-294, ASTM F-667). OTHER PIPE AND FITTINGS NOT SPECIFIED HEREIN MAY BE USED ONLY WHEN SPECIFICALLY AUTHORIZED IN WRITING BY THE CITY.
- 4. ALL STORM SEWERS SHALL BE HIGH PRESSURE WATER JET CLEANED, MAINLINE STORM SEWERS (MANHOLE TO MANHOLE) SHALL BE TELEVISED, LATERAL STORM SEWERS (MANHOLE TO INLET, INLET TO INLET) IN SEVERS OF 40 FT. SHALL ALSO BE TELEVISED, MAINLINE STORM SEWERS AND LATERAL STORM SEWERS THAT ARE 36" DIAMETER OR LESS SHALL BE SUBLECTED TO A DEFLECTION TEST USING A GO-NO-GO MANDREL (95% DIAMETER) WHEN CONSTRUCTED USING FLEXIBLE PIPE CONDUIT MATERIALS. MAINLINE STORM SEWERS AND LATERAL STORM SEWERS THAT ARE GREATER THAN 36" DIAMETER PROUNDET THEN DEADLY TESTING AND CERTIFICATION (DAILY) OF THE REFIDING INSTALL AND INSTALL AREA. SECURE THEO PARTY TESTAL AND SEPTEMBER OF THE BODDING DISEASE OF THE BODDING T
- TRENCHES, WITHIN THE RIGHT OF WAY, UNDER PAYED AREAS (INCLUDING SIDEWALKS)
 SHALL BE BACK FILED WITH FLOWABLE FILL PER INDIANA DEPARTMENT OF
 TRANSPORTATION STANDARD SPECIFICATIONS LATEST EDITION, SECTION 211 AND THE CITY
 STREET CUT DETAIL. FLOWABLE FILL TO EXTEND FIVE FEET BEYOND THE LIMITS OF PAYED
 AREA WITH A 1:1 SLOPE TO THE BOTTOM OF THE TRENCH.
- CONFIGURATION OF INLETS IN PRIVATE PARKING OR DRIVING AREAS MAY BE VARIED TO ACCOMMODATE THE DIMENSIONS OF THE CASTINGS, PRIOR WRITTEN APPROVAL OF THE CITY IS REQUIRED.
- 7. 18" VERTICAL SEPARATION AND 10'-0" HORIZONTAL SEPARATION TO BE MAINTAINED BETWEEN WATER MAINS, HYDRANTS, STORM SEWERS, AND SANITARY SEWERS.
- 8. SEWER PERMIT AND CITY INSPECTION REQUIRED FOR ALL CONNECTIONS TO STORM SEWER SYSTEMS. SEWER PERMIT REQUIRED ON SITE DURING ANY SEWER CONSTRUCTION.
- ALL TAPS TO CONCRETE PIPE SHALL BE MADE WITH BOOT AND SADDLE CONNECTORS AND SHALL BE CORE DRILLED ONLY.
- 10. ALL INLETS SHALL BE DEPRESSED 0.1 FT. BELOW PLAN GRADE.
- 11. ALL SEWER LINES SHALL HAVE 0.1 FT. DROP THROUGH MANHOLES.
- 12. CASTINGS SHALL BE CENTERED ON OPENING IN STRUCTURES.
- 13. MINIMUM 4" OPENING REQUIRED ON BACK OF CURB INLET CASTING
- 14. TOP OF MANHOLE FRAMES TO BE SET AT PROPOSED YARD OR SIDEWALK GRADE WHEN LOCATED IN FRONT AREA OF LOT OR RIGHT OF WAY.
- 15. BICYCLE SAFE GRATES REQUIRED IN PAVED AREAS EXCLUDING PAVED FLOW LINES IN SWALES OR DETENTION AREAS.
- 16. ANIMAL GUARDS SHALL BE PERMANENTLY INSTALLED ON ALL PIPE END SECTIONS 18" OF LARGER IN DIAMETER. GUARDS SHALL HAVE A MAXIMUM CLEAR OPENING OF 4" AND BE REMOVABLE.
- 17. IF ANY EXISTING FIELD TILE SYSTEMS ARE ENCOUNTERED DURING THE CONSTRUCTION PROCESS THE CONTRACTOR SHALL BE RESPONSIBLE FOR RECONSTRUCTING THE TITLE TO ITS ORIGINAL CONDITION OR CONNECT IT INTO THE PROPOSED STORM DRAIN SYSTEM.
- 18. WHENEVER PROPRIETARY EQUIPMENT IS SPECIFIED OR "APPROVED EQUAL" IS IMPLIED ALL PROPOSALS FOR SUBSTITUTIONS SHALL BE SUBMITTED TO THE CITY IN WRITING FOR THEIR APPROVAL.
- ALL PIPE CONNECTIONS TO STRUCTURES OR OTHER PIPES SHALL BE INSPECTED BY THE CITY PRIOR TO BACKFILL PLACEMENT.

TELEVISION INSPECTION CRITERIA

STORM SEWERS

SEWERS SHALL BE "FLOODED" BEFORE TELEVISION INSPECTION. THE IMAGE SHALL BE CLEAR ENOUGH TO ENABLE THE CITY REPRESENTATIVE AND OTHERS VIEWING THE MONITOR TO EASILY EVALUATE THE INTERIOR CONDITION OF THE

ALL UNACCEPTABLE CONDITIONS FOUND DURING TELEVISION INSPECTION MUST BE CORRECTED BY THE CONTRACTOR AND RETELEVISED.

UNACCEPTABLE CONDITIONS THAT ADVERSELY EFFECT THE ABILITY OF THE SYSTEM TO FUNCTION AS DESIGNED OR TO BE PROPERLY MAINTAINED AND MAY INCLUDE, BUT ARE NOT LIMITED TO, THE FOLLOWING.

A. PROTRUDING TAPE OF SHALTY PIPE

C. MISALICALED OR DEFORMED PIPE

D. DEBRIS IN LINE

E. INFILERATION/EXPLITATION

F. EXCESSIVE GAPS AT JOINTS

G. BELLIES OR SAGS WITH A DEPTH GREATER THAN OR EQUAL TO 10% (OR of MAXIMUM OF 3") OF PIPE DIAMETER AND/OR A LENGTH GREATER THAN 25
FEET

- MAXIMUM OF 3") OF PIPE DIAMETER AND/OR A LENGTH GREATER THEET
 DETAILS AS TO REQUIRED CCTV EQUIPMENT AND REQUIRED TELEVISION
 INSPECTION REPORT ARE AVAILABLE FROM THE CITY ENGINEER'S OFFICE.

Columbus			DWN BY: AJB
REVISIONS	DATE	BY	DATE: 12/23/2014
			scale: N.T.S.
			14.1.0.

CITY OF COLUMBUS

OFFICE OF CITY ENGINEER 123 WASHINGTON STREET COLUMBUS, INDIANA 47201

STORM SEWER TYPICAL DETAILS AND NOTES

SHEET TITLE:

N MANHOLE SECTIONS).

в" <u>мін.</u>

-CONCRETE BENCH WALL TO BE SHAPED APPROXIMATELY AS SHOWN TO DRAIN AND DIRECT FLOW, BENCH WALL RADIUS TO START A MINIMUM OF 6" FROM END OF PIPE, FIELD MODIFICATION OF PRE CAST BENCH WALLS TO BE PERFORMED UNDER DIRECTION OF CITY.

CERT.	SHEET:	OF:
	JOB No.	DRG. No.
FILE:		

